




Proposed floor plans Scale ~ 1:100

RWG indicates rain water gulley - to discharge into soak a way to rear garden.

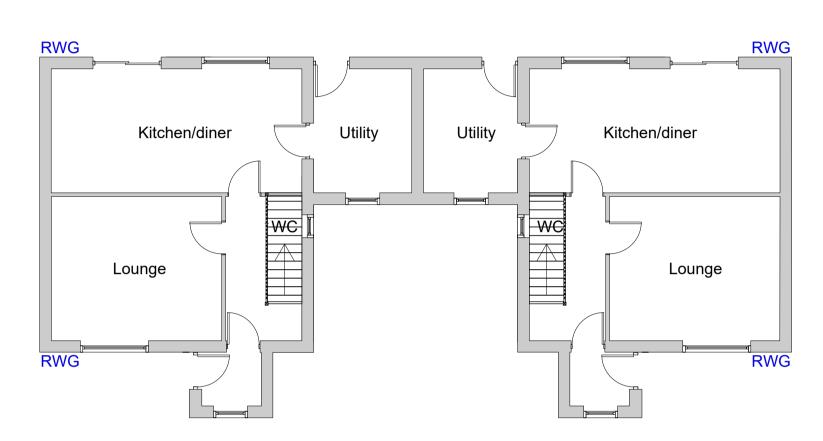



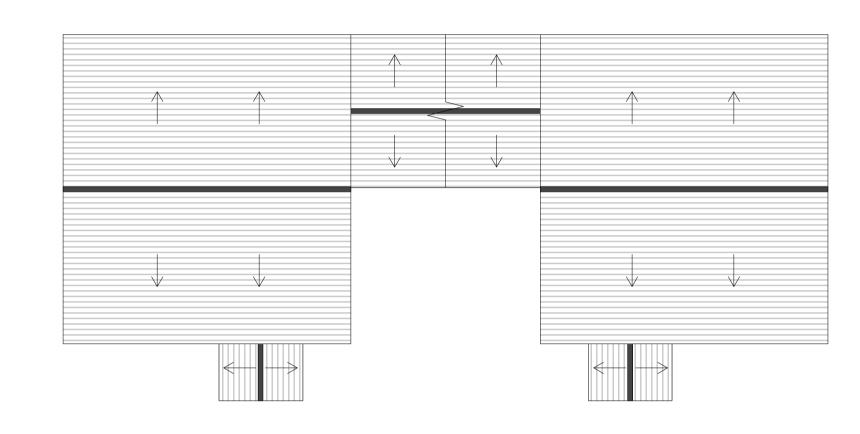

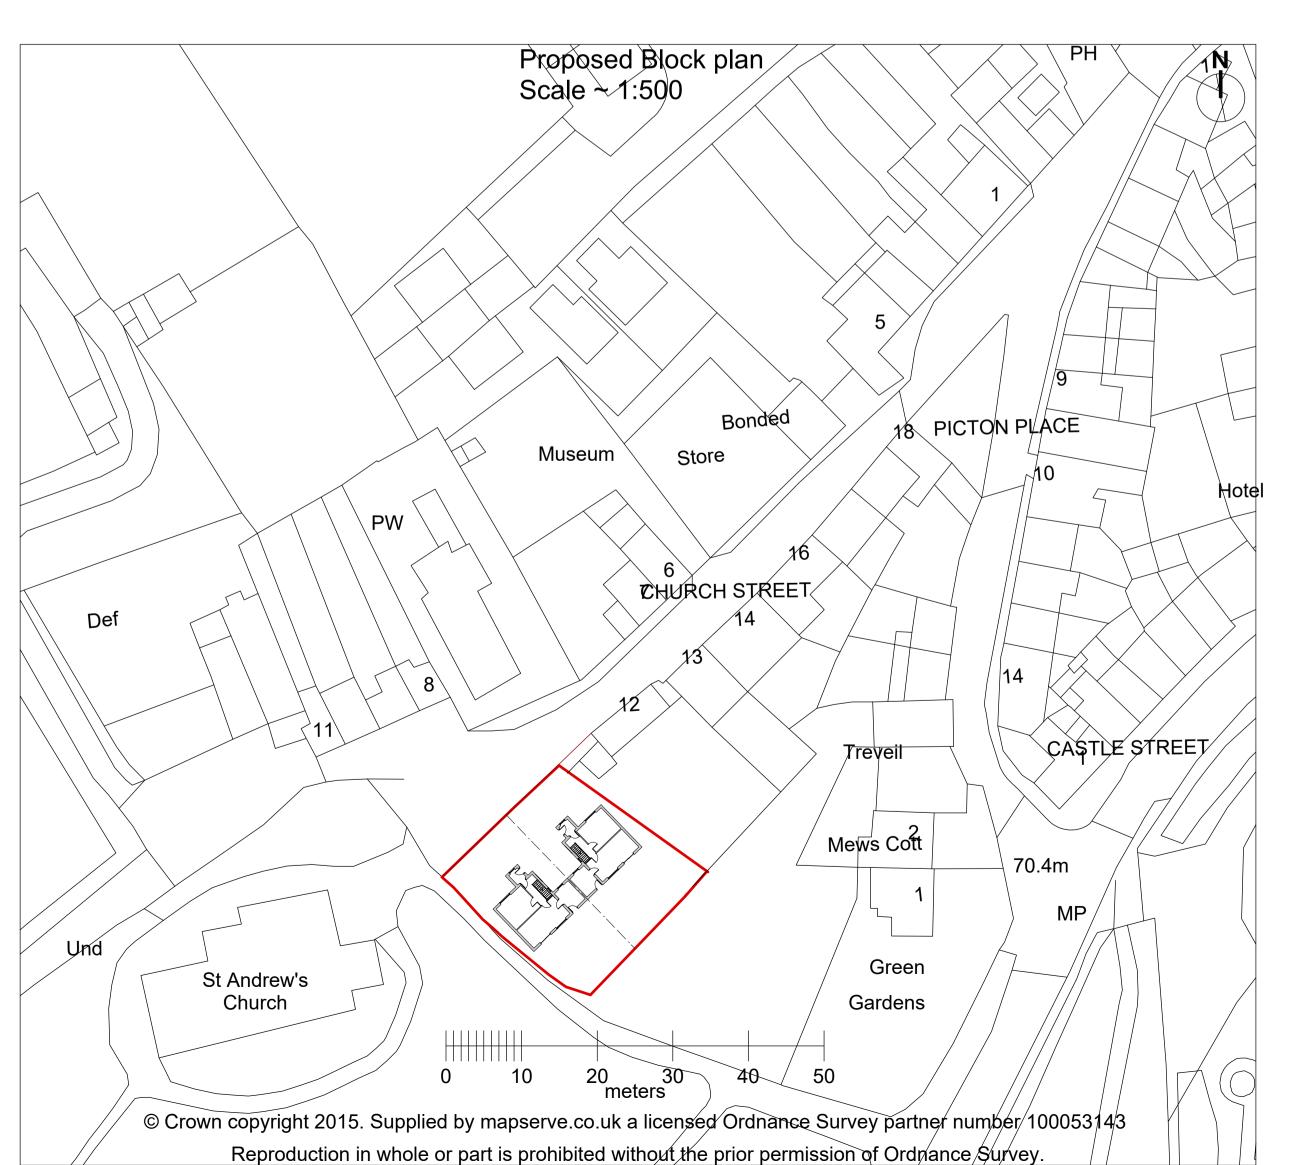

Material finishes ~

Roof ~ thin profile blue/black slate;


Walls ~ Stone work where indicated with smooth render to remaining walls;

Windows and doors ~ Brown UpVC;

Facia and soffits ~ Brown UpVC;

Guttering ~ OG continuos aluminuim

Existing location plan Scale ~ 1:1250

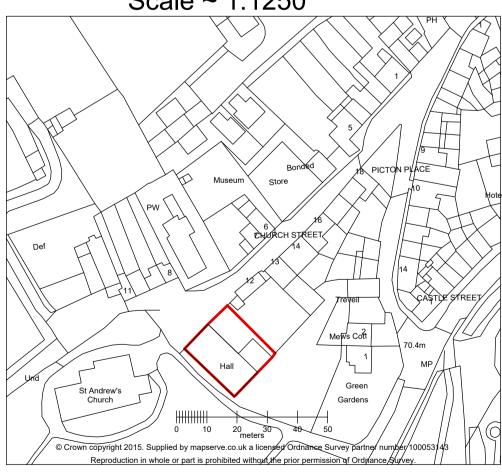

General ~

The contractor is to ensure that proposed Works will be executed in accordance with any relevant. Conditions appended to the Local Planning Authority's Decision Notice; the current Building Regulations and N.H.B.C. Standards; the requirements of the Fire Officer; the

Institute of Electrical Engineers
handbook (current edition); the requirements of the local
Water Authority. Materials
and workmanship should, where applicable, comply with
the current British Standards
Institute specifications and Codes of Practice. Where

Institute specifications and Codes of Practice. Where such guidance does not exist, materials and workmanship should conform to established good practice and Regulation 7 of Building Regulations.

All Materials and components must be suitable for their intended purpose and location and must be manufactured and installed in accordance with all Relevant, Current British Standards and codes of practice, Building Control requirement and manufacturer's specification.

The location of existing services should be established prior to the commencement of any works - if discovered to be at variance with that shown on the Engineering drawings, the Architect and Engineer must be notified immediately.

The contractor is to check all dimensions, both internal and external, prior to the commencement of any works and the ordering of materials - any errors must be reported to the design team.

Where proprietary materials, fixtures or fittings are used, they must be placed / fitted strictly in accordance with the manufacturers written instructions and published details pertaining to circumstance in which they are to be used.

This specification is to be read in conjunction with all other drawings, clients standard specification, Structural Engineers and Mechanical & Electrical Engineers design.

Any reference to an Approved Document in this Specification relates to the relevant Approved Document of the Building Regulations.

PL VER 1	All measurements must be checked on site. If there are any deviations the designer should be notified and written conformation sought.
	The plans are the property of M. Baggott Chartered Surveyors and Architectural Service and written permission must be sought before passing any plans onto third parties.
	Party Wall agreements should be put in place before any works commence on site.

Issue Notes

MARK BAGGOTT CHARTERED
--SURVEYORS AND
ARCHITECTURAL PRACTICE

Mark Baggott Chartered Surveyors

& Architectural Practice p. 01559371550

m. 07717292879

e. mark@baggottmark.co.uk

Mark Baggott

Proposed development of 2No dwellings at St Andrews Hall, Church Street, Narberth, Pembroekshire. SA67 7BH.


Title

No. Date

Proposed floor plans

Project Manager N/A	Project ID ST ANDREWS NARBERTH
Drawn By MB	1:100; 1:50;
Reviewed By	Sheet No.
Date 08/07/2016	
CAD File Name CHURCH OF WALES	PAPER A1

Existing topographical plan Scale ~ 1: 200

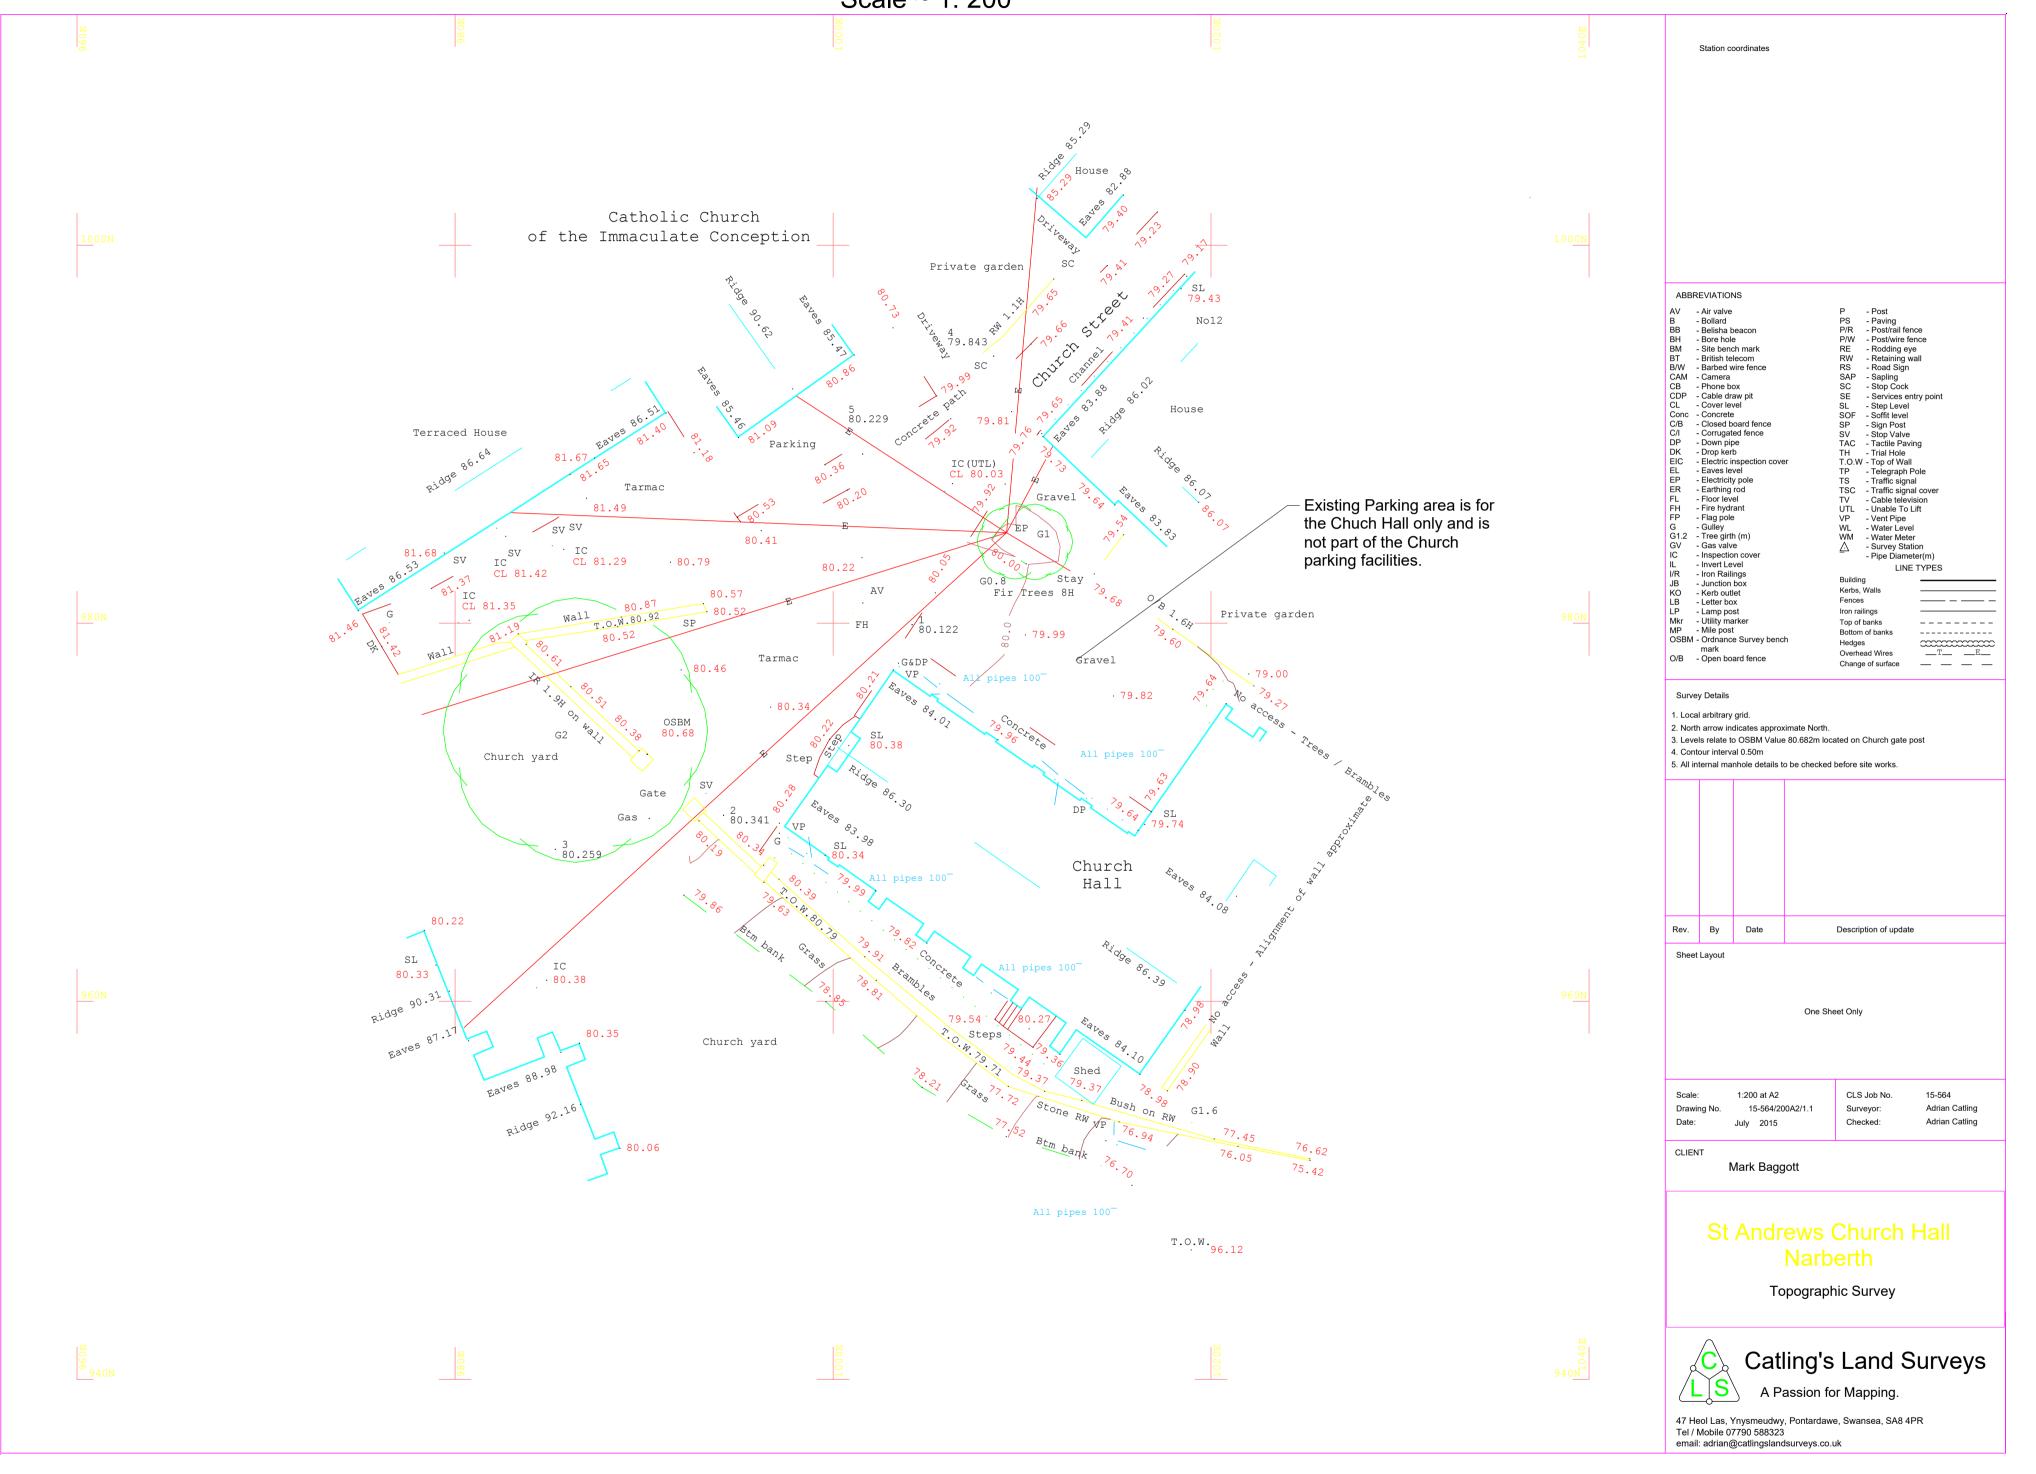

PL VER 1	08/07/16	All measurements must be checked on site. If there are any deviations the designer should be notified and written conformation sought. The plans are the property of M. Baggott Chartered Surveyors and Architectural Service and written permission must be sought before passing any plans onto third parties. Party Wall agreements should be put in place before any works commence on site.			
No.	Date	Issue Notes			
	MARK BAGGOTT CHARTERED -SURVEYORS AND ARCHITECTURAL PRACTICE				
Design	Mark Baggott Chartered Surveyors & Architectural Practice p. 01559371550 m. 07717292879 e. mark@baggottmark.co.uk				


Proposed floor plans

Mark Baggott

Proposed development of 2No dwellings at St Andrews Hall, Church Street, Narberth, Pembroekshire. SA67 7BH.

Project Manager N/A	ST ANDREWS NARBERTH
Drawn By MB	1:100; 1:50;
Reviewed By	Sheet No.
Date 08/07/2016	of3
CAD File Name CHURCH OF WALES	PAPER A1

Proposed topographical plan Scale ~ 1: 200

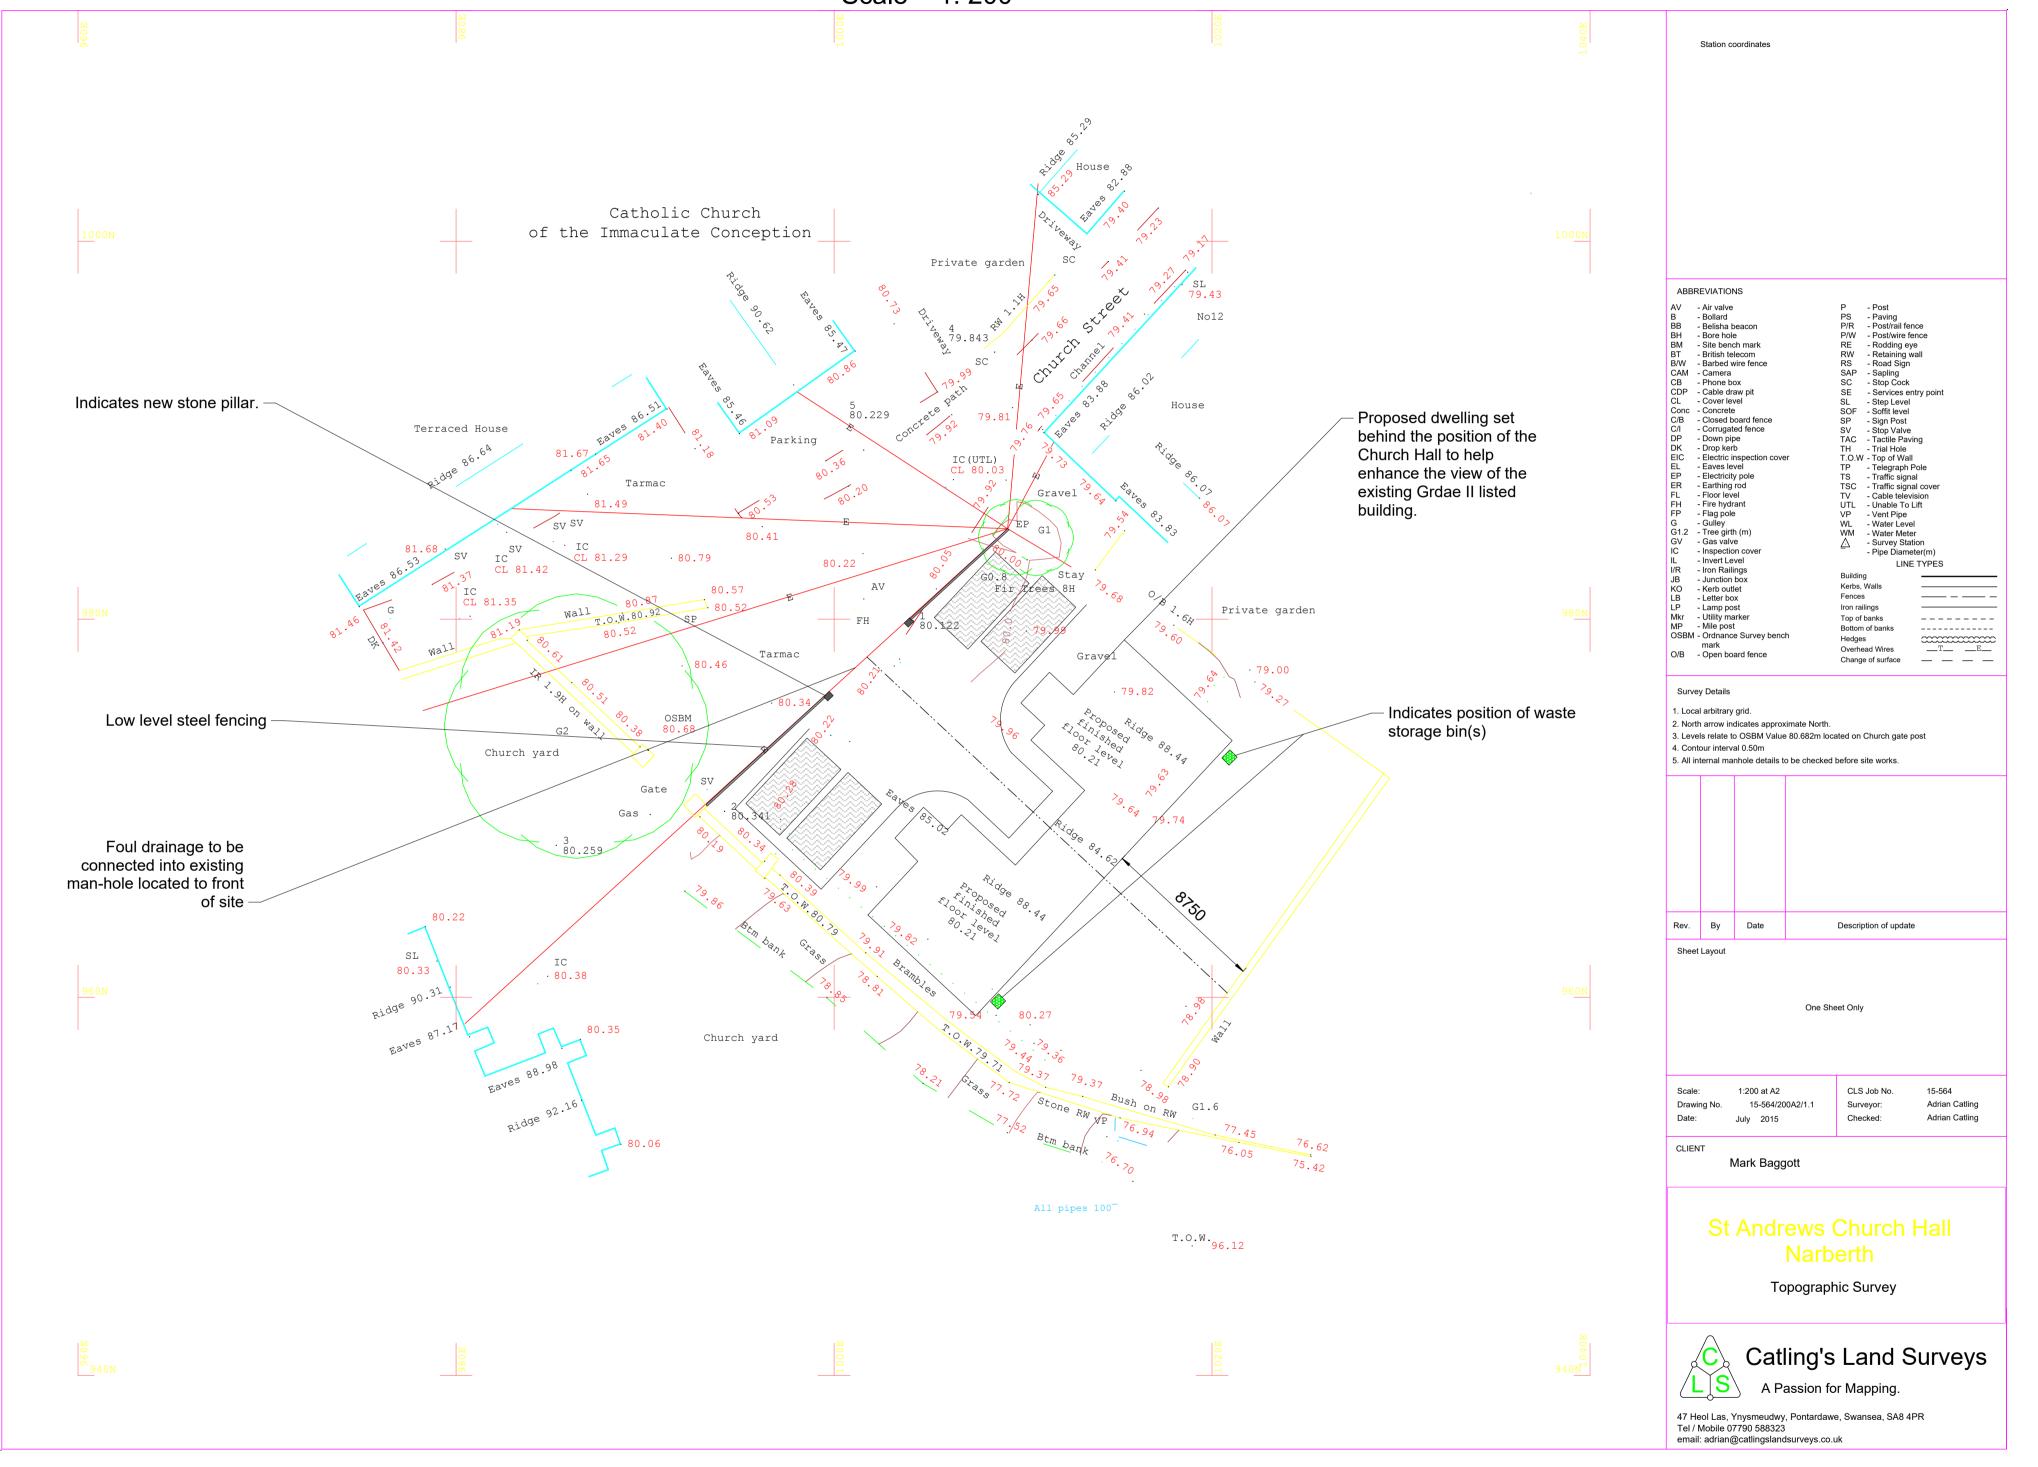

	PL VER 1		All measurements must be checked on site. If there are any deviations the designer should be notified and written conformation sought. The plans are the property of M. Baggott Chartered Surveyors and Architectural Service and written permission must be sought before passing any plans onto third parties. Party Wall agreements should be put in place before any works commence on site.	
	No.	Date	Issue Notes	
_		SURVE	BAGGOTT CHARTERED YORS AND TECTURAL PRACTICE	
	Mark Baggott Chartered Surveyors & Architectural Practice p. 01559371550 m. 07717292879 e. mark@baggottmark.co.uk			

Proposed floor plans

Project ID ST ANDREWS NARBERTH

MB Scale 1:100; 1:50;

Sheet No.

Mark Baggott

Proposed development of 2No dwellings at St Andrews Hall, Church Street, Narberth,

Pembroekshire. SA67 7BH.